
### **DRAWING LIST**

01

SITE PLAN A01 LAYOUT&FDN PLANS A02 A03 **ELECT&PLUM PLAN** A04 **ROOF&ROOF FRAMING PLAN** A30 **ELEVATIONS** A50 **SECTIONS** A200 **DETAILS** A201 **OPENING SCHEDULE** 

**COVER PAGE** 

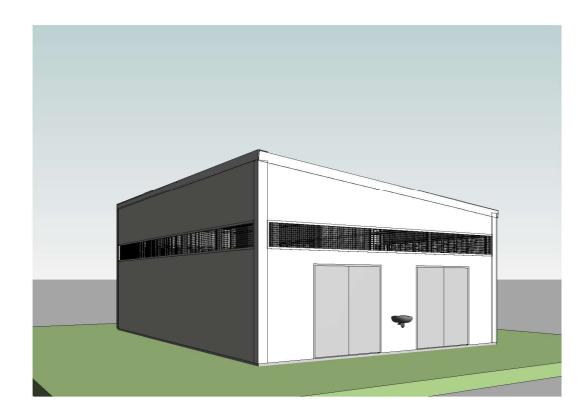

# **TDS**

TECHNICAL DESIGN SERVICES
ARCHITECTURAL UNIT
MINISTRY OF INFRASTRUCTURE &
SUSTAINABLE ENERGY
PO BOX 498
BETIO, TARAWA
REPUBLIC OF KIRIBATI
PHONE: +686 75126192
EMAIL: design@mise.gov.ki

### **INCINERATOR SHED**

CLIENT: MHMS PROJECT NO: 032306

DWG TITLE:

### **COVER PAGE**


KB JT DRAWN BY: REVIEWED BY: DATE: SCALE: 22/02/24

DRAWING NUMBER:

ISSUE:

01

**DETAIL** DESIGN

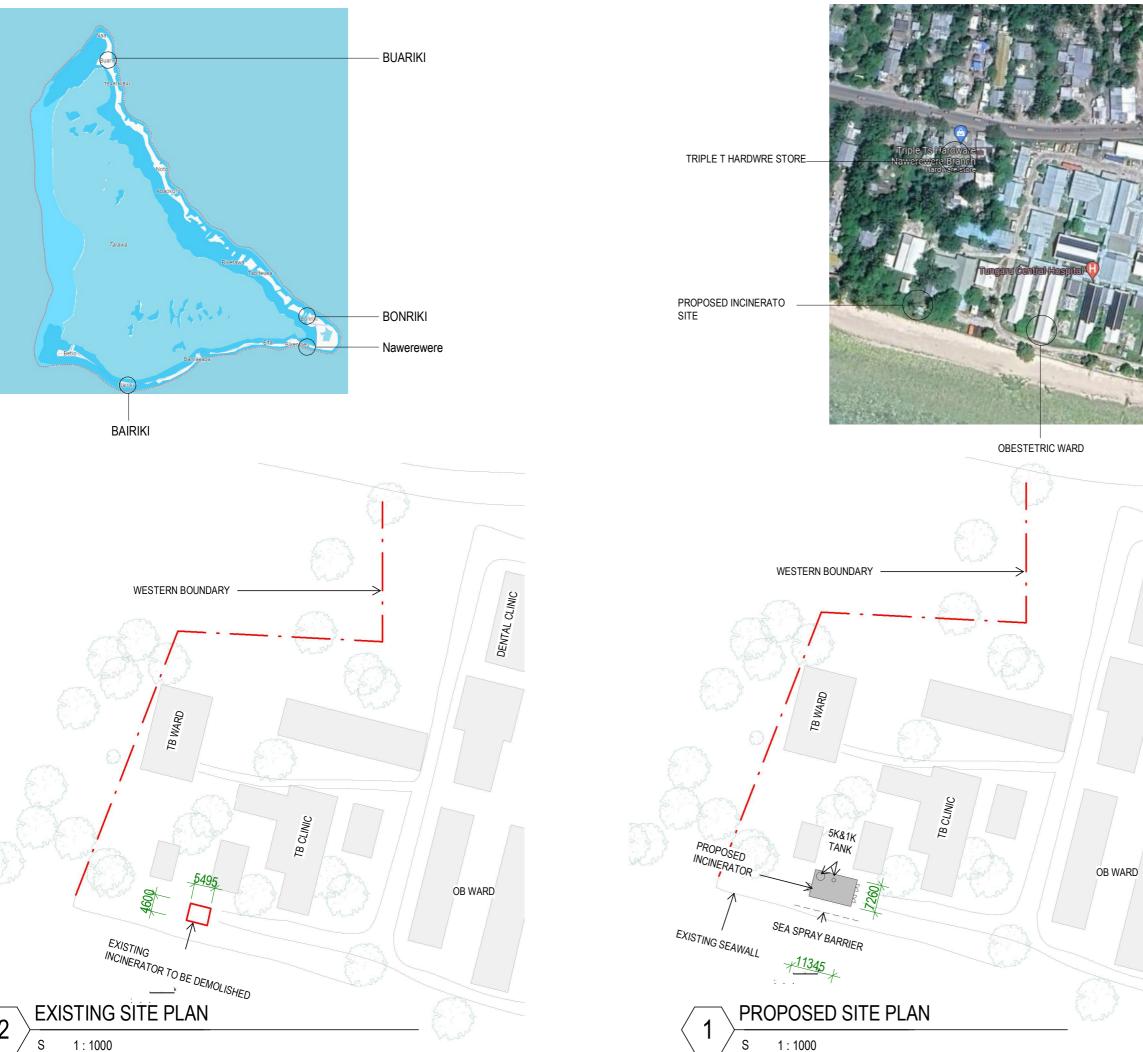



**TDS** 

TECHNICAL DESIGN SERVICES
ARCHITECTURAL UNIT
MINISTRY OF INFRASTRUCTURE &
SUSTAINABLE ENERGY
PO BOX 498
BETIO, TARAWA
REPUBLIC OF KIRIBATI
PHONE: +686 75126192
EMAIL: design@mise.gov.ki

## **INCINERATOR SHED**

CLIENT: PROJECT NO: MHMS 032306

DWG TITLE: SITE PLAN

DRAWN BY: REVIEWED BY:

22/02/24


DATE: SCALE: As indicated

DRAWING NUMBER:

A01

ISSUE:

**DETAIL** DESIGN

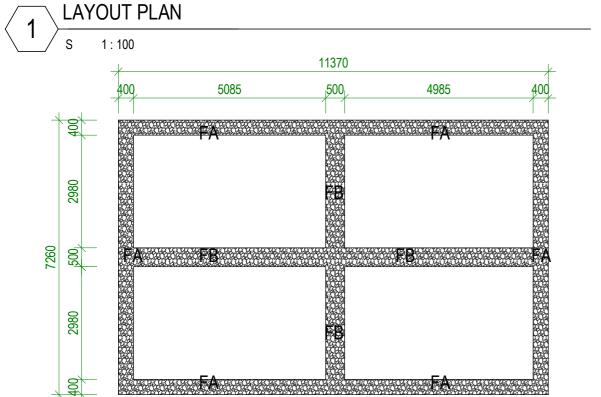

FΑ

A30

0

1K&5K STAINLESS STEEL RWT

A30

2070

Incinerator

WASTE STORAGE

A30

A50

**FOUNDATION PLAN** 

1800

1800

A30

## **INCINERATOR SHED**

CLIENT:

MHMS 032306

#### LAYOUT&FDN PLANS

DRAWN BY: REVIEWED BY:

22/02/24 As indicated SCALE:

DRAWING NUMBER:

ISSUE:

**DETAIL DESIGN** 

100 THICK

CONCRETE

R6 STIRRUPS @

MINIMUM 50mm

OF CONCRETE

5no. D10 BARS WITH

**COVER TO BOTTOM** 

**CENTRES** 

BEAM

FLØOR SLAB

TECHNICAL DESIGN SERVICES ARCHITECTURAL UNIT MINISTRY OF INFRASTRUCTURE & SUSTAINABLE ENERGY PO BOX 498 BETIO, TARAWA REPUBLIC OF KIRIBATI

PHONE: +686 75126192 EMAIL: design@mise.gov.ki

PROJECT NO:

DWG TITLE:

KΒ DATE:



## PLUMBING PLAN

1:100

#### NOTE:

- GREY AND BLACK WATER DRAINAGE PIPES BOTH CONNECTED TO PUB SEWER LINE. - DIRECTION OF INLET AND OUTLET PIPES DEPENDS ON LOCATION OF P.U.B. SERVICES IN **RELATION TO THE BUILDING** ORIENTATION ON SITE.
- STORAGE TANKS CAN BE INCORPORATED TO **INLET PIPES (TO KITCHEN SINKS)** - OR TANKS SIMPLY HAVE DIRECT TAP **OUTLETS**
- TANKS CONCRETE BASE STAND SHOULD BE IN LEVEL WITH THE BUILDING FLOOR LEVEL
- WC CONNECTED TO P.U.B. SALT WATER LINE OR WELL WATER FROM ONSITE HEADER TANK
- SINKS, SHOWERS AND LAUNDRY TAPS CONNECTED TO P.U.B. CLEAN WATER LINE OR WELL WATER FROM ONSITE HEADER TANK

#### PLUMBING NOTES AND SPECIFICATIONS:

USE STAINLESS STEEL FOR ALL DRAINAGE PIPES, ABOVE AND BELOW GROUND.

#### **PLUMBING LEGEND**

- INLET MIN. 65mm NOMINAL DIAMETER (DN)
- **OUTLET (SIZES REFER NOTES BELOW)**

MIN. SIZE OF TRAP OUTLET 465 DN MIN. FOR ALL BRANCH DRAINS AT DIAMETER (DN) IN MM):

40 - BASIN

PLUMBING ITEMS

1 IN 40 MIN. GRADE


- 80 DN MIN. FOR MAIN DRAIN AT 1 IN 60

40 - SHOWER MIN. GRADE

80 - WATER CLOSET PAN

40 - LAUNDRY DRAIN NOTES ARE IN ACCORDANCE TO AS/NZS 50 - KITCHEN SINK

3500.5

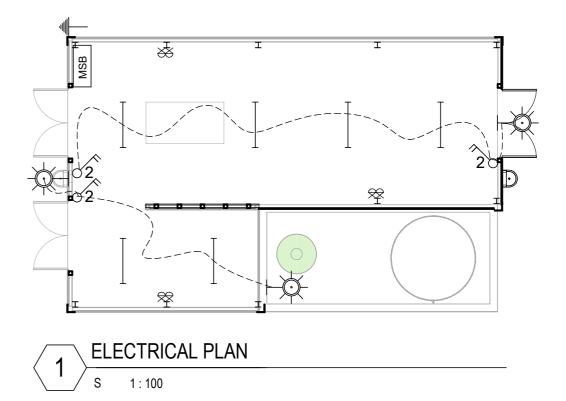

ELECTRICAL SCHEMATIC PLANS SHALL BE INSTALLED BY

4 OR 6 sgmm FOR UNDERGROUND CABLES

FROM PUB BOX TO HOUSEHOLD SWITCHBOARD

2.5 sqmm CABLES CONNECTING SWITCH-BOARD

2.5 sgmm CABLES CONNECTING SWITCH-BOARD

1.5 sqmm CABLES CONNECTING SWITCH-POINTS

TO LIGHTS AND OTHER CEILING/WALL MOUNTED

A QUALIFIED AND LICENSED ELECTRICIAN/ENGINEER

WHERE APPLICABLE, USE ENERGY EFFICIENT

APPLIANCES & LED LIGHTS

TO GPOS

**APPLIANCES** 

TO SWITCH POINTS

CABLE WIRE SIZES SHOULD BE:

#### **ELECTRICAL LEGEND**

MSB

Main switch board

 $\Re$ Double GPO

0.02

Light switch single, doulbe.

NOTE:





Cable wire



Light batten double

### **FIRE SAFETY**



ABE fire extinguisher to AS2444 portable fire extinguishers and fire blankets. Place max 1200mm from finished floor level to top of existinguisher or min. 100mm from finished floor level to bottom of extinguiser



Earth Cable

## **ELECTRICAL LEGEND**

1:100

1 REVISED

Date 1

TECHNICAL DESIGN SERVICES ARCHITECTURAL UNIT MINISTRY OF INFRASTRUCTURE & SUSTAINABLE ENERGY PO BOX 498 BETIO, TARAWA REPUBLIC OF KIRIBATI PHONE: +686 75126192 EMAIL: design@mise.gov.ki

#### **INCINERATOR SHED**

MHMS

CLIENT: PROJECT NO:

032306

DWG TITLE:

**ELECT&PLUM PLAN** 


KΒ DRAWN BY: JΤ REVIEWED BY: 22/02/24 DATE: 1:100 SCALE:


DRAWING NUMBER:

ISSUE:

**DETAIL DESIGN** 

1:100

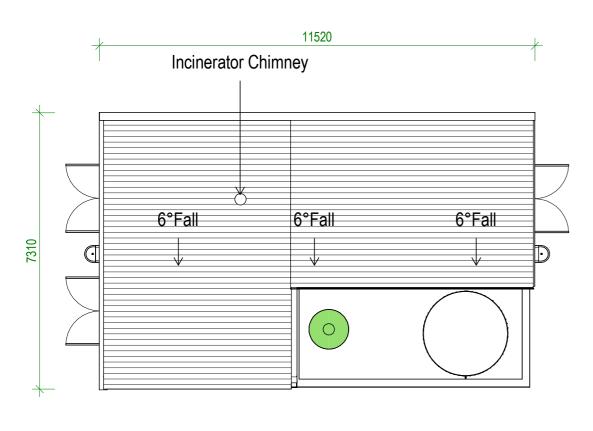

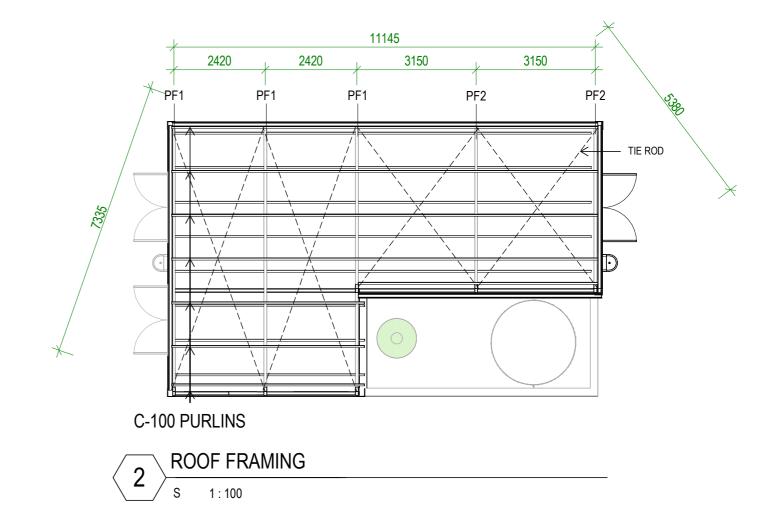

4 SHOWING FRAMES

 $\mathsf{ADD}$ 

TECHNICAL DESIGN SERVICES
ARCHITECTURAL UNIT
MINISTRY OF INFRASTRUCTURE &
SUSTAINABLE ENERGY
PO BOX 498
BETIO, TARAWA
REPUBLIC OF KIRIBATI
PHONE: +686 75126192
EMAIL: design@mise.gov.ki

## **INCINERATOR SHED**

CLIENT: MHMS PROJECT NO: 032306

DWG TITLE:

# ROOF&ROOF FRAMING PLAN


DRAWN BY: KB
REVIEWED BY: JT
DATE: 22/02/24
SCALE: 1:100


DRAWING NUMBER:


ISSUE:


DETAIL DESIGN


ROOF

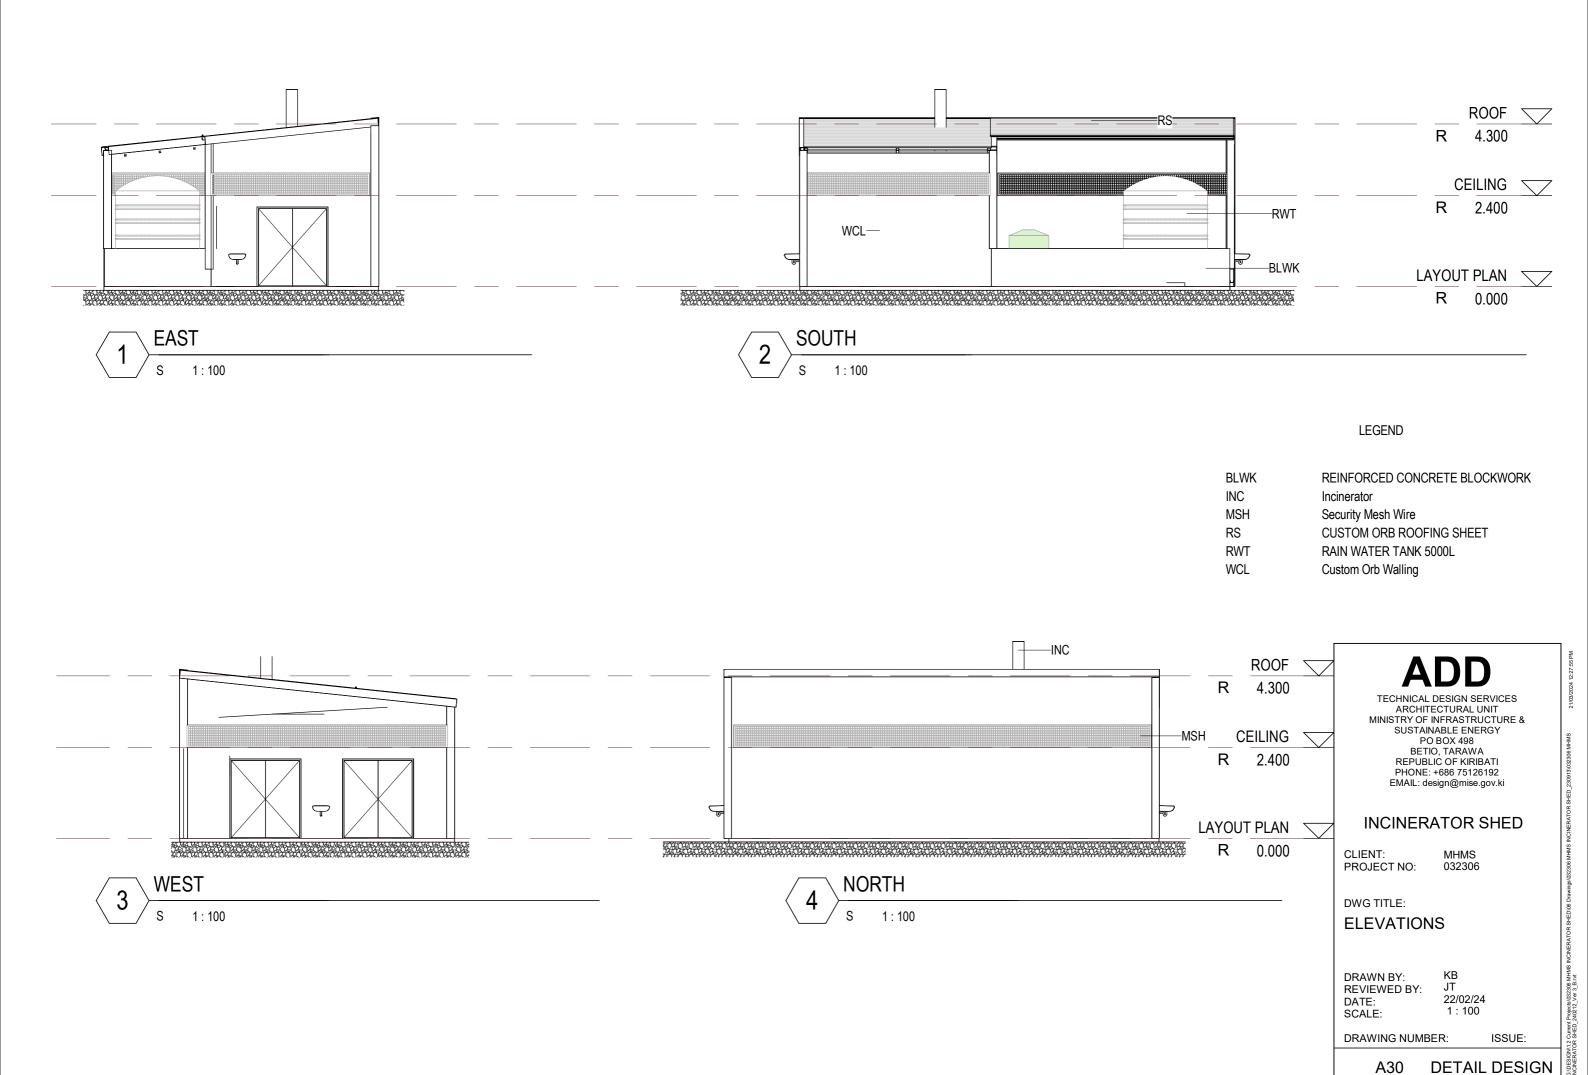

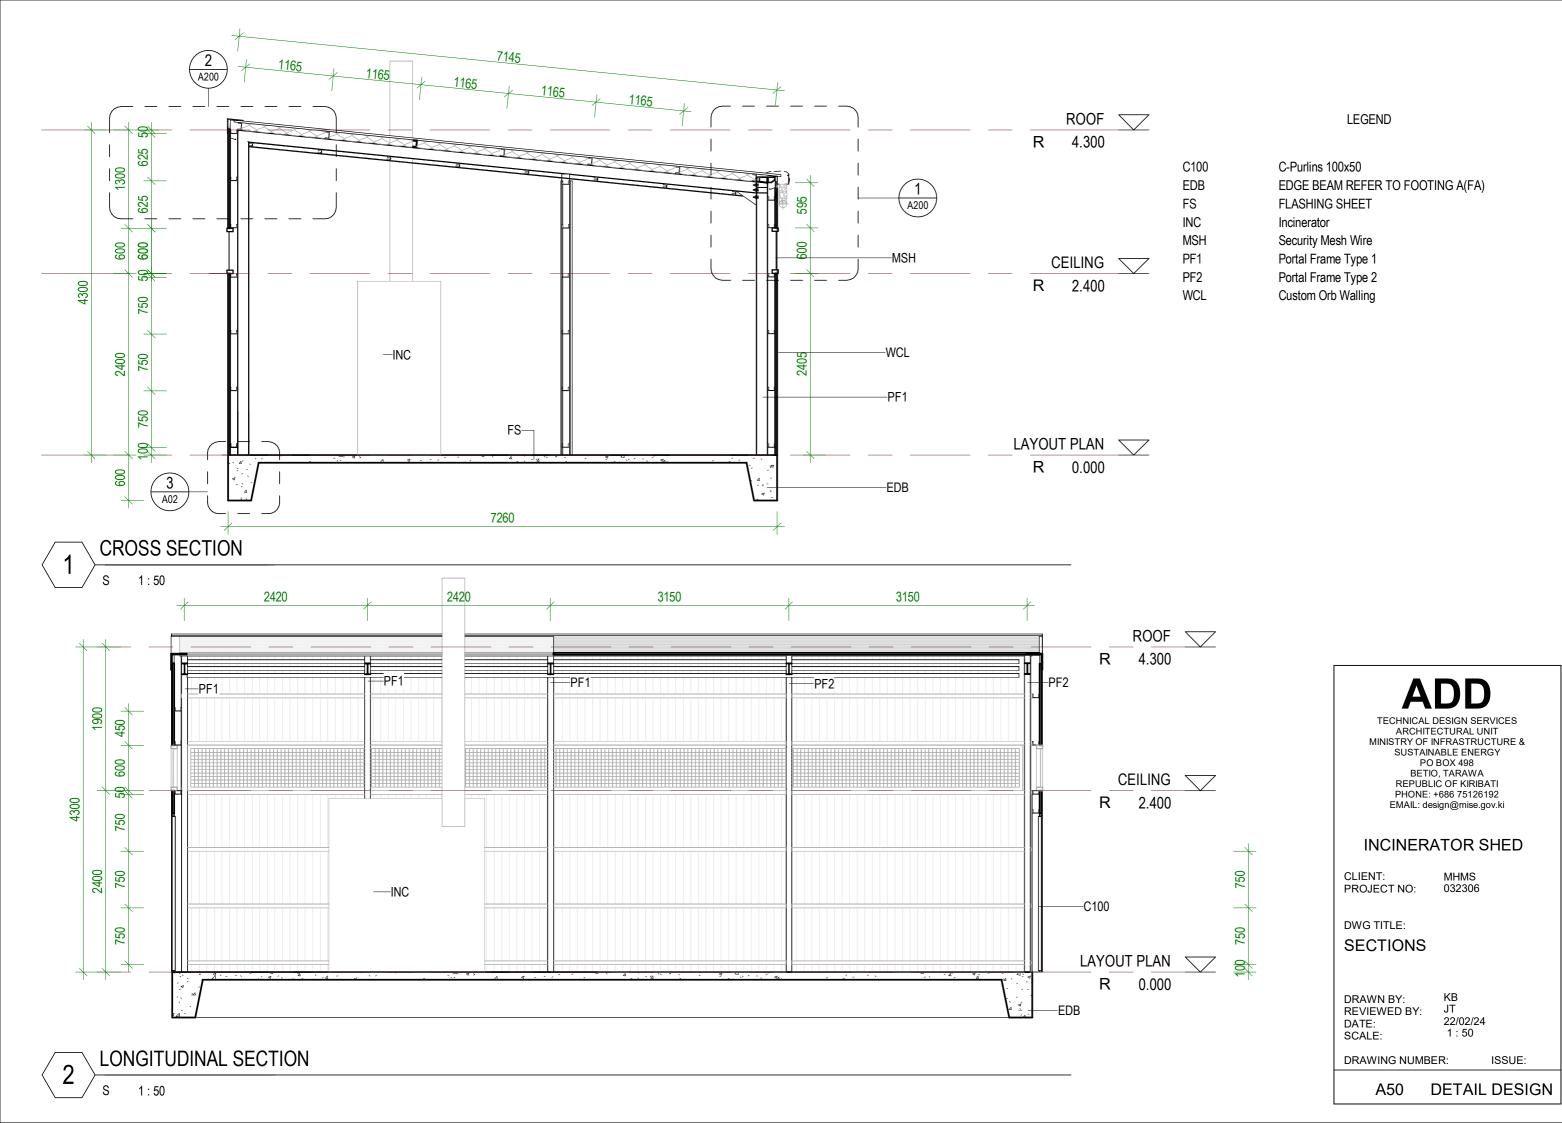


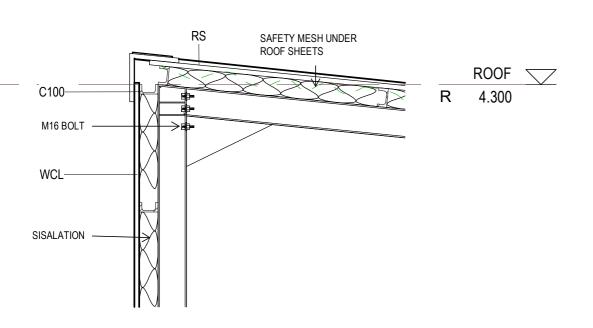

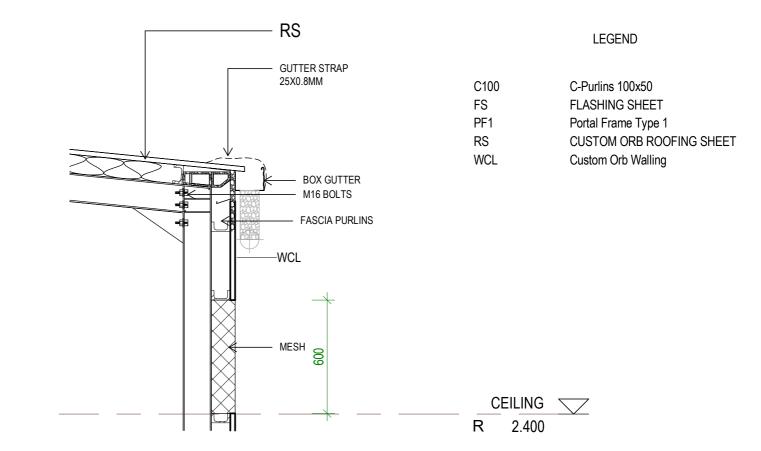

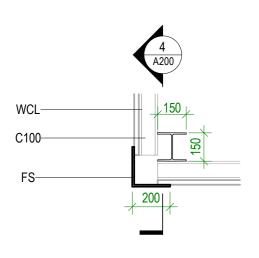

**DETAIL - HIGHER COLUMN** 

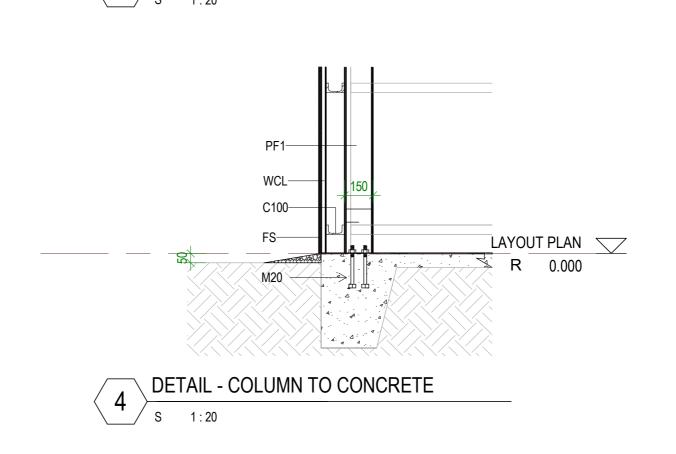

**DETAIL - LOWER COLUMN** 


TECHNICAL DESIGN SERVICES ARCHITECTURAL UNIT MINISTRY OF INFRASTRUCTURE & SUSTAINABLE ENERGY PO BOX 498 BETIO, TARAWA REPUBLIC OF KIRIBATI PHONE: +686 75126192 EMAIL: design@mise.gov.ki **INCINERATOR SHED** CLIENT: MHMS PROJECT NO: 032306 DWG TITLE: **DETAILS** KB JT DRAWN BY: REVIEWED BY: DATE: SCALE: 22/02/24

A200 DETAIL DESIGN

ISSUE:

DRAWING NUMBER:

3 DETAIL - I-BEAM+GIRT+FLASHING
s 1:20

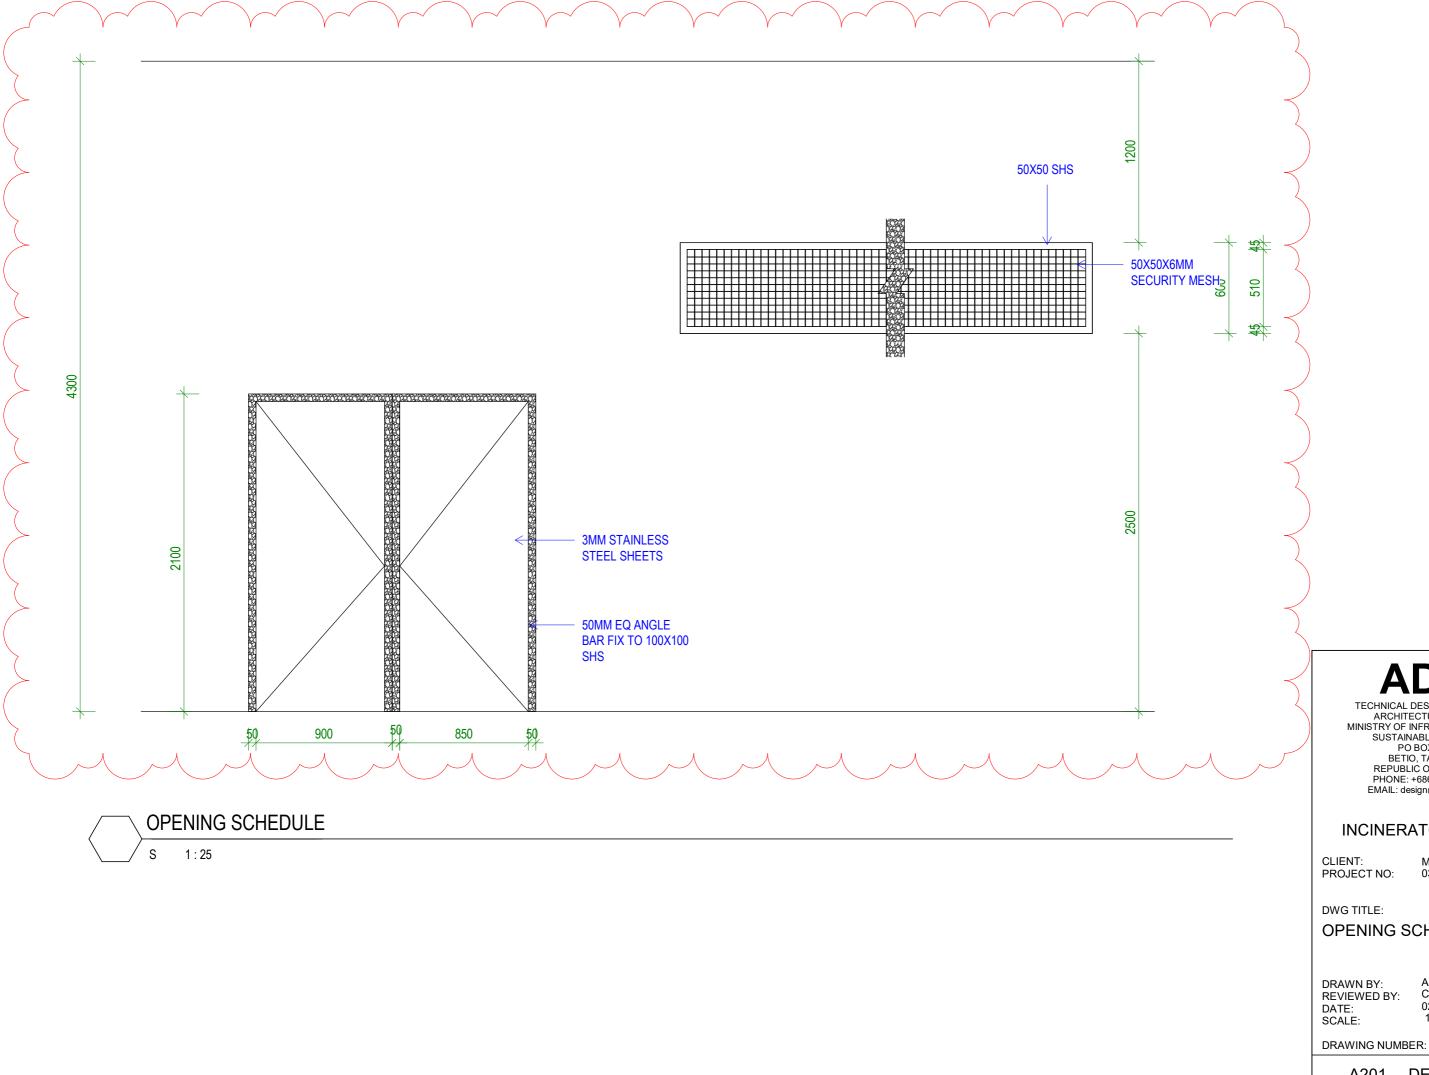

TECHNICAL DESIGN SERVICES ARCHITECTURAL UNIT MINISTRY OF INFRASTRUCTURE & SUSTAINABLE ENERGY PO BOX 498 BETIO, TARAWA REPUBLIC OF KIRIBATI PHONE: +686 75126192 EMAIL: design@mise.gov.ki

### **INCINERATOR SHED**

MHMS 032306

#### **OPENING SCHEDULE**

Author Checker

02/29/24

A201 DETAIL DESIGN

ISSUE:

REFER ANY DISCREPENCIES TO ARCHITECT FOR RESOLUTION.

#### **ROOF PLUMBING**

#### **GUTTERS**

ZINCALUME FINISH STEEL EAVES GUTTERING, LYSAGHT 125 QUAD OR APPROVED EQUIVALENT. FIX GUTTER TO TIMBER FASCIA WITH MATCHING GUTTER

FALL GUTTER TO DOWNPIPES AT A MINIMUM GRADIENT OF 1 IN 400. TEST FALL OF GUTTER BY FILLING WITH WATER AND ENSURING WATER FULLY DRAINS TO DOWNPIPES.

INSTALL GUTTERS PRIOR TO FIXING ROOF SHEETING.

DO NOT USE PVC PIPE INSTEAD OF STEEL GUTTERING.

#### **DOWNPIPES**

100 DIA. UPVC - PAINT FINISH.

#### **ROOFING**

**CUSTOM ORB ROOF SHEET** FIX STEEL ROOFING TO TIMBER ROOFING BATTENS WITH GALVANISED ROOFING **SCREWS** 

#### **RIDGE AND BARGE CAPPINGS**

FOLDED STEEL SHEET - ZINCALUME ZINISH

FIX CAPPINGS THROUGH STEEL ROOFING TO TIMBER ROOFING BATTENS WITH **GALVANISED ROOFING SCREWS** 

#### **RAINWATER TANKS**

5000&1000 LITRE POLYETHELENE RAINWATER TANK ON CONCRETE FLOOR. PROVIDE ALUMINIUM MESH INSECT SCREEN AT INLET IN TOP OF TANK.

#### **ROOF FRAMING**

REFER TO SECTIONS AND DETAILS FOR C-PURLINS.

BE SURE TO INSTALL ALL BOTTOM CHORD TIES, ROOF BRACING AND TIES TO TOP PLATES.

#### **CEILING BATTENS/NOGGINGS**

Product Code:S5150,Lengths 2400xBMT 0.5xWidth 51xDepth/Height 36 PRODUCT CODE: S5150 - LENGTH 2400 X BMT O.5 X WIDTH 51 X DEPTH/HEIGHT 36

#### **BLOCKWORK & CONCRETING**

#### **CONCRETE BLOCKS**

390x190x190 CONCRETE BLOCKS LAID IN STRETCHER BOND. 10mm FLUSH JOINTED MORTAR TO SPECIFICATION. RUN STRING LINE FOR ALL BLOCKWORK COURSES. DO NOT TOOL JOINTS.

CHECK DETAILS FOR INSTALLATION OF REINFORCING. **BACKFILL HOLLOW BLOCKS WITH GROUT** 

Construction Specification

#### **BLOCKWORK FINISH**

FLUSH JOINTED MORTAR (DO NOT TOOL JOINTS).

#### **MORTAR MIX**

**CEMENT:SAND RATIO** 

#### **GROUT MIX**

DESIGN MIX TO CONFIRM TO A MINIMUM OF 20 MPa AGGREAGATE(10MM) USE AT LEAST 300KG OF CEMENT PER CUBIC METRE OF CONCRETE

USE AT LEAST 300KG OF CEMENT PER CUBIC METRE OF CONCRETE.

#### **CONCRETE MIX**

DESIGN MIX TO CONFIRM TO A MINIMUM OF 20 MPa AGGREAGATE(20MM) LAY CONCRETE SLAP OVER BLACK PLASTIC SHEETING, 50MM SAND BLINDING AND 150MM COMPACTED HARDCORE WATER: CEMENT: SAND: AGGREGATE (20mm) RATIO

LAY CONCRETE SLAB OVER BLACK PLASTIC SHEETING, 50mm SAND BLINDING AND 150mm COMPACTED HARDCORE

#### REINFORCING

ALL STEEL REINFORCING TO BE MINIMUM GRADE 300MPa

SELECTED FLOOR TILE

SELECTED WALL TILE (UP TO 1200mm AT TOILET WET AREAS)

SELECTED FLOOR NON SLIP TILES AT TOILET WET AREAS

#### **EXTERNAL PAINTING**

WINDOW FRAMES AND FASCIA 1 COAT 1 STEP OIL BASED PRIMER SEALER UNDERCOAT 2 COATS OF SEMI-GLOSS ENAMEL COLOUR: TO BE SELECTED

#### **INTERNAL PAINTING**

INTERNAL WALLS AND CEILINGS 1 COAT SEALER 2 COATS WASH AND WEAR LOW SHEEN COLOUR: SELECTED WHITE

TRIMS (SKIRTINGS, ARCHITRAVES, INTERNAL DOORS & FRAMES) 1 COAT 1 STEP OIL BASED PRIMER SEALER UNDERCOAT 2 COATS OF SEMI-GLOSS ENAMEL **COLOUR: SELECTED WHITE** 

# TECHNICAL DESIGN SERVICES

ARCHITECTURAL UNIT MINISTRY OF INFRASTRUCTURE & SUSTAINABLE ENERGY PO BOX 498 BETIO, TARAWA REPUBLIC OF KIRIBATI PHONE: +686 75126192 EMAIL: design@mise.gov.ki

#### **INCINERATOR SHED**

CLIENT: MHMS PROJECT NO: 032306

DWG TITLE:

## CONSTRUCTION **SPECIFICATION**


T.Titaake DRAWN BY: **REVIEWED BY:** DATE: SCALE:


P.T/T.T/T.M 12/02/15 1:20

DRAWING NUMBER:

ISSUE:

A250 **DETAIL DESIGN**  Surrent SHED

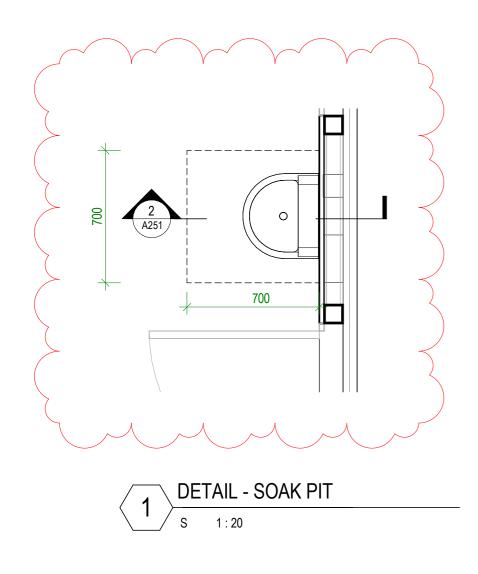

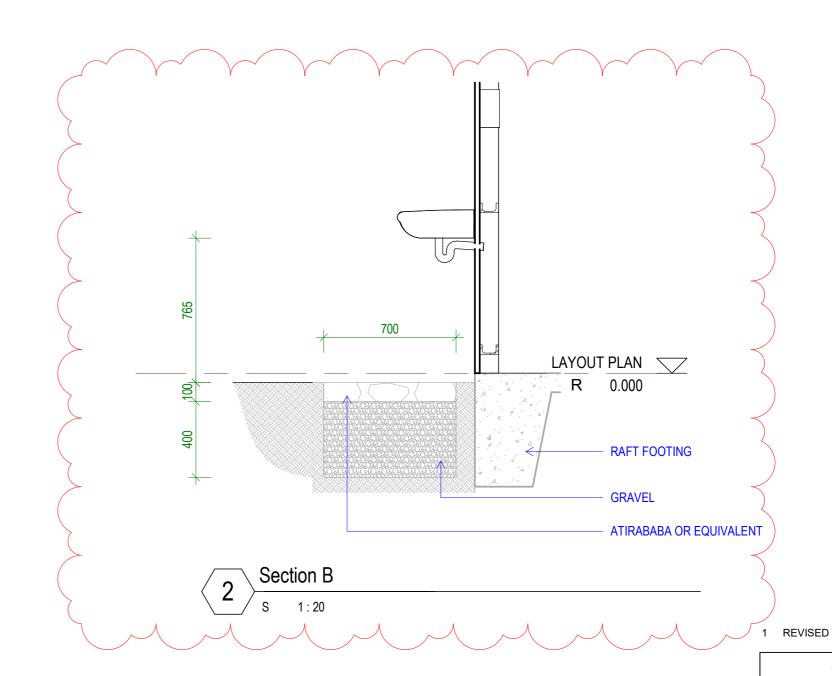

**TDS** 

TECHNICAL DESIGN SERVICES
ARCHITECTURAL UNIT
MINISTRY OF INFRASTRUCTURE &
SUSTAINABLE ENERGY
PO BOX 498
BETIO, TARAWA
REPUBLIC OF KIRIBATI
PHONE: +686 75126192
EMAIL: design@mise.gov.ki

## INCINERATOR SHED

CLIENT: PROJECT NO:

MHMS 032306

DWG TITLE:

DETAILS - SOAK PIT

DRAWN BY: KB
REVIEWED BY: JT
DATE: 21/03/24
SCALE: 1:20

DRAWING NUMBER:

ISSUE:

A251

DETAIL DESIGN 3 MHMS 21/03/2024 12:27:59 PM

Date 1